

PROJECT FOR THE NEW RESIDENCE OF
DR. PABLO UMANSKY



DR AB
SPECIM DONE
8/10/2021 -
DESIGN
NOT APPROVED
VARIANCE
APPLICATION
FOR 2ND FLOOR
STEP IN EXEMPT
ONLY

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Town of Golden Beach
Building Regulatory Advisory Board
Hearing Date

AUG 10 2021

APPROVED _____
DISAPPROVED _____
VARIANCE REQ. _____
BRAB REVIEW SET (REV #1)

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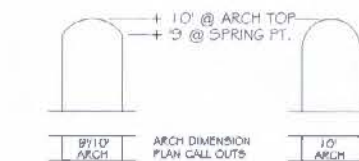
UMANSKY, DR. PABLO
185 OCEAN BLVD
GOLDEN BEACH
FLORIDA 33160

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







REVISIONS

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SYMBOLS LEGEND



MATERIALS LIST

	STRUCTURAL CONC. COLUMN OR SHEER WALL
	CONCRETE BLOCK
	STRUCTURAL BEARING WALL
	1HR FIRE-RATED PARTITION (AS PER S.F.B.C. 37-B #79)
	GYPSUM BOARD
	CONCRETE, MORTAR, OR GROUT
	PLYWOOD
	FINISH WOOD

COVER SHEET

DRAWN
A.T.
CHECKED
S.A.
DATE
07/15/2021
SCALE
1/4" = 1'-0"
JOB NO.
20 4992
SHEET

A-00

OF # SHEETS

Lot: A0000277 ARCH R #: A00012001 ADDRESS: HISTORIC DELIDA PARK, PROFESSIONAL DISTRICT, 303 DIXIE BOULEVARD, DELRAY BEACH, FLORIDA, 33444. PHONE: (561)274-6440, FAX: (561)274-6440.

ETS

OF # SHEETS

[illegible]

3D VIEWS

DRAWN	
A.T.	
CHECKED	
S.A.	
DATE	07/15/2021
SCALE	
JOB NO.	20 4892
SHEET	
A-01	
OF	#
SHEETS	



Shane Ames - Architect

[illegible]

BRAB REVIEW SET (REV #1)

UMANSKY, DR. PABLO
185 OCEAN BLVD
GOLDEN BEACH
FLORIDA 33160

APPROVED _____
DISAPPROVED _____
VARIANCE REQ: _____

Unit: AA0002307 ARCH# : AR0012001 ADDRESS : HISTORIC DELIDA PARK, PROFESSIONAL DISTRICT, 203 DIXIE BOULEVARD, DELRAY BEACH, FLORIDA, 33444. PHONE : (561)274 6444, FAX : (561)2746445

LOT 18, BLOCK "A", SECTION "C" OF GOLDEN BEACH, ACCORDING TO THE PLAT THEREOF, AS
RECORDED IN THE PLAT BOOK 9, PAGE 52, OF THE PUBLIC RECORDS OF MIAMI-DADE COUNTY,
FLORIDA.

1. SURVEY DATA IS BASED ON INFORMATION PROVIDED BY BASELINE ENGINEERING & LAND SURVEYING, INC.
2. THE ELEVATIONS ARE PROVIDED IN THE NATIONAL GEODETIC VERTICAL DATUM (NGVD 1929)
3. FLOOD ZONE AE, BASE FLOOD EL. = 7', MAP DATE 09/11/09; MAP NUMBER 12086 0153L
4. PRIOR TO CONSTRUCTION, THE CONTRACTOR SHALL GIVE TIMELY NOTIFICATION TO ALL UTILITY COMPANIES WITH FACILITIES IN THE AREA.
5. THE LOCATION OF EXISTING FACILITIES WERE PLOTTED FROM AVAILABLE RECORDS. THE CONTRACTOR SHALL FIELD LOCATE ALL EXISTING UTILITIES PRIOR TO CONSTRUCTION.
6. THE CONTRACTOR SHALL TAKE ALL NECESSARY PRECAUTIONS TO SAFEGUARD ALL EXISTING STRUCTURES, UTILITIES, AND SURVEY MARKERS.
7. ALL SIDEWALKS AND PATIOS SHALL BE SLOPED AWAY FROM HOUSE.
8. MAXIMUM GRASS SLOPES SHALL NOT EXCEED 4:1
9. CONTRACTOR SHALL COORDINATE GRADING PLAN WITH LANDSCAPE PLAN

1. PROVIDE FILTER FABRIC OR OTHER METHOD OF SEDIMENT PROTECTION FOR ANY EXISTING CATCH BASIN/INLET WITHIN 100 FEET OF THE PROPERTY. ANY SEDIMENT THAT IS TRACKED ONTO THE ROAD MUST BE SWEEPED UP IMMEDIATELY. SEDIMENT SHALL NOT BE REMOVED BY WASHING/FLUSHING WITH WATER AT THE RIGHT OF WAY.
2. AT ALL TIMES DURING CONSTRUCTION, ALL STORMWATER MUST REMAIN ONSITE. NO DISCHARGE IS ALLOWED INTO THE PUBLIC RIGHT OF WAY.
3. CONTRACTOR SHALL USE BEST MANAGEMENT PRACTICES IN ORDER TO PROVIDE STORMWATER EROSION AND SEDIMENTATION CONTROL FOR THE SITE AND ESPECIALLY BEYOND THE LIMITS OF EXCAVATION.
4. A 5" CHANNEL DRAIN SHALL BE INSTALLED ACROSS THE WIDTH OF THE POOL DECK AND SHALL BE BY FERROCO OR EQUAL.
5. THE CHANNEL DRAIN SHALL DISCHARGE THROUGH A 6 INCH POLY PIPE INTO A DRY WELL/ EXFILTRATION TRENCH SYSTEM.
6. INSTALL DRAINAGE SYSTEMS AND SWALES AS PER DETAILS.
7. ADJUST EXISTING UTILITIES AS MAYBE REQUIRED TO MEET THE NEW GRADES.

BUILDING FOOTPRINT	3,108 SQ FT	25.90 %
POOL/DECK/GAZEBO	2,540 SQ FT	36.72 %
MOTOR COURT/GARBAGE AREA	1,946 SQ FT	63.28 %
TOTAL AREA	12,000 SQ FT	100.00 %
TOTAL PERVIOUS AREA	4,406 SQ FT	36.72 %
TOTAL IMPERVIOUS AREA	7,594 SQ FT	63.28 %

* 10.78

EXISTING ELEVATION (MGVD)

EX WATER METER

PROP. CLEAN OUT


PROPERTY LINE

5.00

PROP. SITE GRADE (NGVD)

PROP. SWALE

PROP. CATCH BASIN

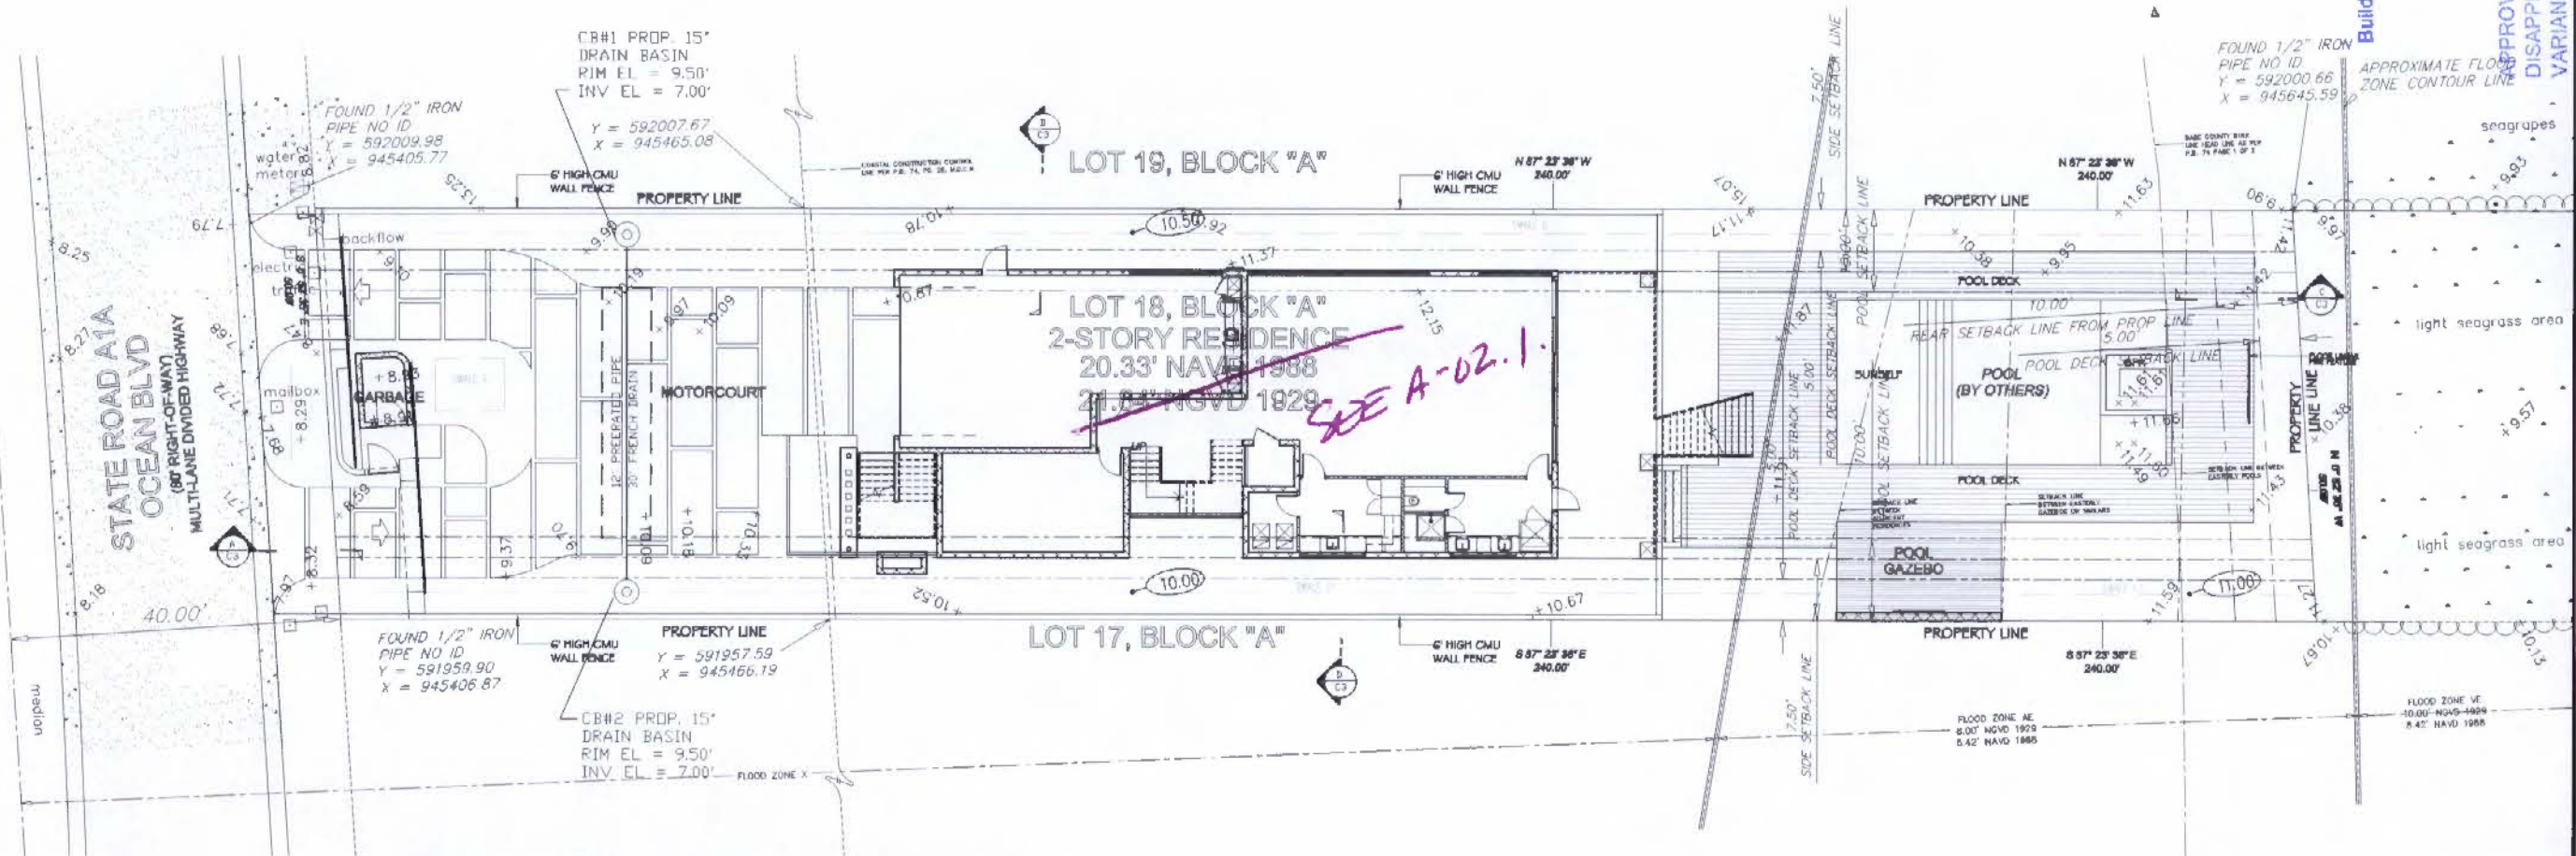

**Town of Golden Beach
Building Regulatory Advisory Board
Hearing Date**

AUG 10 2021

APPROVED
DISAPPROVED
VARIANCE REQ:

UMANSKY RESIDENCE
185 S OCEAN BOULEVARD
GOLDEN BEACH, FL 33160

REVISIONS		
NO.	DATE	DESCRIPTION

GEA PROJECT NO. : 21061
DATE : 05-28-2021
SCALE AS SHOWN
DESIGNED BY : R.B.J.
DRAWN BY : L.B.
CHECKED BY : R.B.J.
APPROVED BY : R.B.J.

SHEET TITLE

CIVIL PLAN

C2 OF 3

SEAL

DATE: 8080-JACKSON, P. E.
REGINA
PL. P.E. NO.: 38550

PRODUCED BY AN AUTODESK EDUCATIONAL PRODUCT

PRODUCED BY AN AUTODESK EDUCATIONAL PRODUCT

STORAGE CALCULATIONS:

SEE THE DRAINAGE COMPUTATIONS FOR THE VOLUME OF RUNOFF TO BE CONTAINED ON SITE. $V = 4,360$ CF

SWALE A = $(53.67 \text{ SF} \times 0.5') + (29.58' \times 2\frac{1}{2}' \times 0.50') = 41.63$ CF
SWALE B = $(230' \times 4.33\frac{1}{2}' \times 0.50') = 248.97$ CF
SWALE C1 = $(178.04' \times 4.33\frac{1}{2}' \times 0.5') = 179.11$ CF
SWALE C2 = $(33.12' \times 4.33\frac{1}{2}' \times 0.5') = 35.85$ CF

TOTAL SWALES = 505.56 CF

EXFILTRATION TRENCH:
BALANCE OF VOLUME REQUIRED: $2854.44 \text{ CF} / (43,560 \text{ AC/FT} \times 12 \text{ IN/FT}) = 1/06\text{-IN}$

COMPUTATION OF TRENCH VOLUME

$$L = \frac{V}{K(H_2W + 2H_2DU + DU^2 + 2H_2DS) + (1.39 \times 10^{-4}KW DU)}$$

(WHEN $DS < DU$)

L = LENGTH OF TRENCH REQUIRED (FEET)

V = VOLUME TO BE EXFILTRATED (AC-IN)

W = TRENCH WIDTH (FEET)

K = HYDRAULIC CONDUCTIVITY (CFS/FT²- FT. HEAD)

H₂ = DEPTH TO WATER TABLE (FEET)

DU = NON-SATURATED TRENCH DEPTH (FEET)

DS = SATURATED TRENCH DEPTH (FEET)

V = 1.06 AC-IN

W = 10.00 FT

K = 2.00×10^{-4} (ASSUMED)

H₂ = 7.50 FT




DU = 6.50 FT

DS = 0.00 FT

$$L = \frac{1.06 / (2.00 \times 10^{-4} ((7.50 \times 10.00) + 2(7.50)(6.50) + (6.50)(6.50) + 2(7.50)(0.00)) + 1.39 \times 10^{-4} (10.00)(6.50))}{1} =$$

$$L = \frac{30.21 \text{ LF}}{30.54 \text{ LF USED}} (3,889.55 \text{ CF})$$





TOTAL VOLUME PROVIDED = 4,395.11 CF > 4,360 CF (REQUIRED)

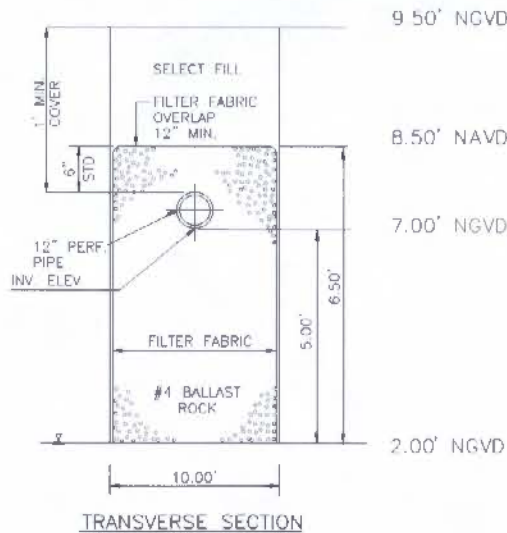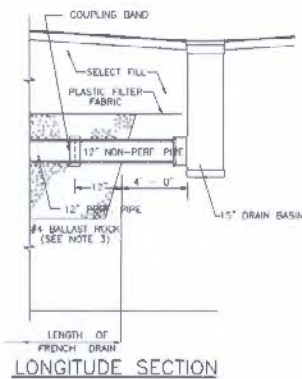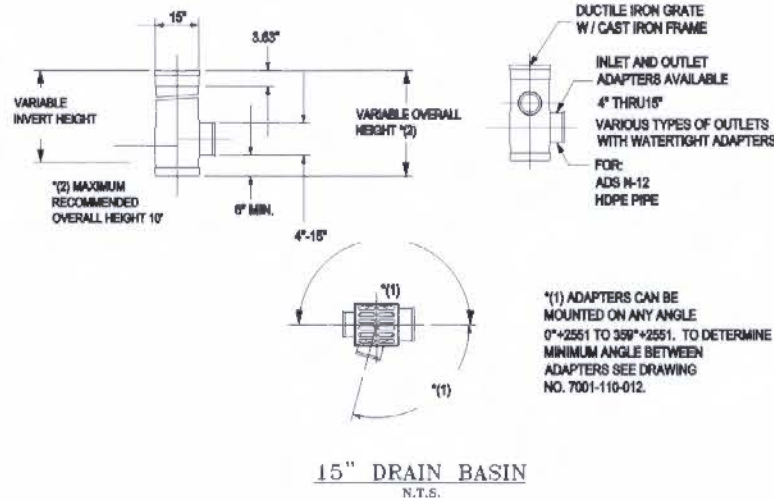

NOTES

1. PLASTIC FILTER FABRIC PER F.D.O.T. STD. INDEX # 285 SHALL BE USED AT EACH SIDE AND ON TOP, AND AT EACH END OF FRENCH DRAIN TRENCH.
2. THE DEPTH OF THE EXFILTRATION TRENCH SHALL BE 6.50 FEET.
3. AFTER THE BALLAST ROCK HAS BEEN PLACED TO THE PROPER ELEVATION IT SHALL BE CAREFULLY VIBRATED OR COMPACTED IN ORDER TO ALLOW FOR INITIAL SETTLEMENT THAT MAY OCCUR. IF IT DOES TAKE PLACE, ADDITIONAL BALLAST ROCK WILL BE ADDED TO RESTORE THE BALLAST ROCK TO THE PROPER ELEVATION SO THAT THE EXFILTRATION TRENCH CAN BE COMPLETED IN ACCORDANCE WITH THE DETAIL.

EXFILTRATION TRENCH DETAIL
N.T.S.

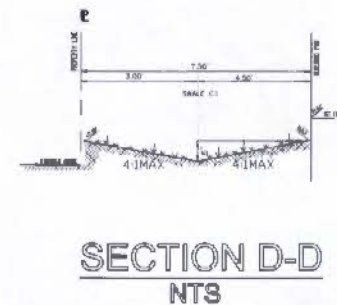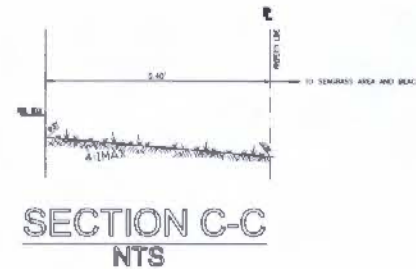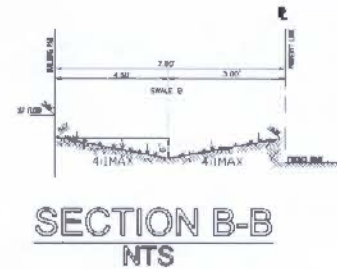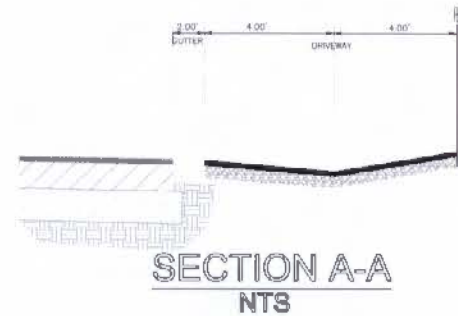

Town of Golden Beach
Building Regulatory Advisory Board
Hearing Date

AUG 10 2021

APPROVED
DISAPPROVED
VARIANCE REQ.



SEAL
DATE: 08/04/2021
DRAWN BY: J. B. J.
CHECKED BY: J. B. J.
P.E. NO.: 38550

UMANSKY RESIDENCE
185 S OCEAN BOULEVARD
GOLDEN BEACH, FL 33160

REVISIONS	DATE	DESCRIPTION

SEA PROJECT NO.: 21061
DATE: 05-28-2021
SCALE: AS SHOWN
DESIGNED BY: R.B.J.
DRAWN BY: J.B.J.
CHECKED BY: J.B.J.
APPROVED BY: J.B.J.

SHEET TITLE

SWALE SECTIONS
& DETAILS

C3 OF 3